

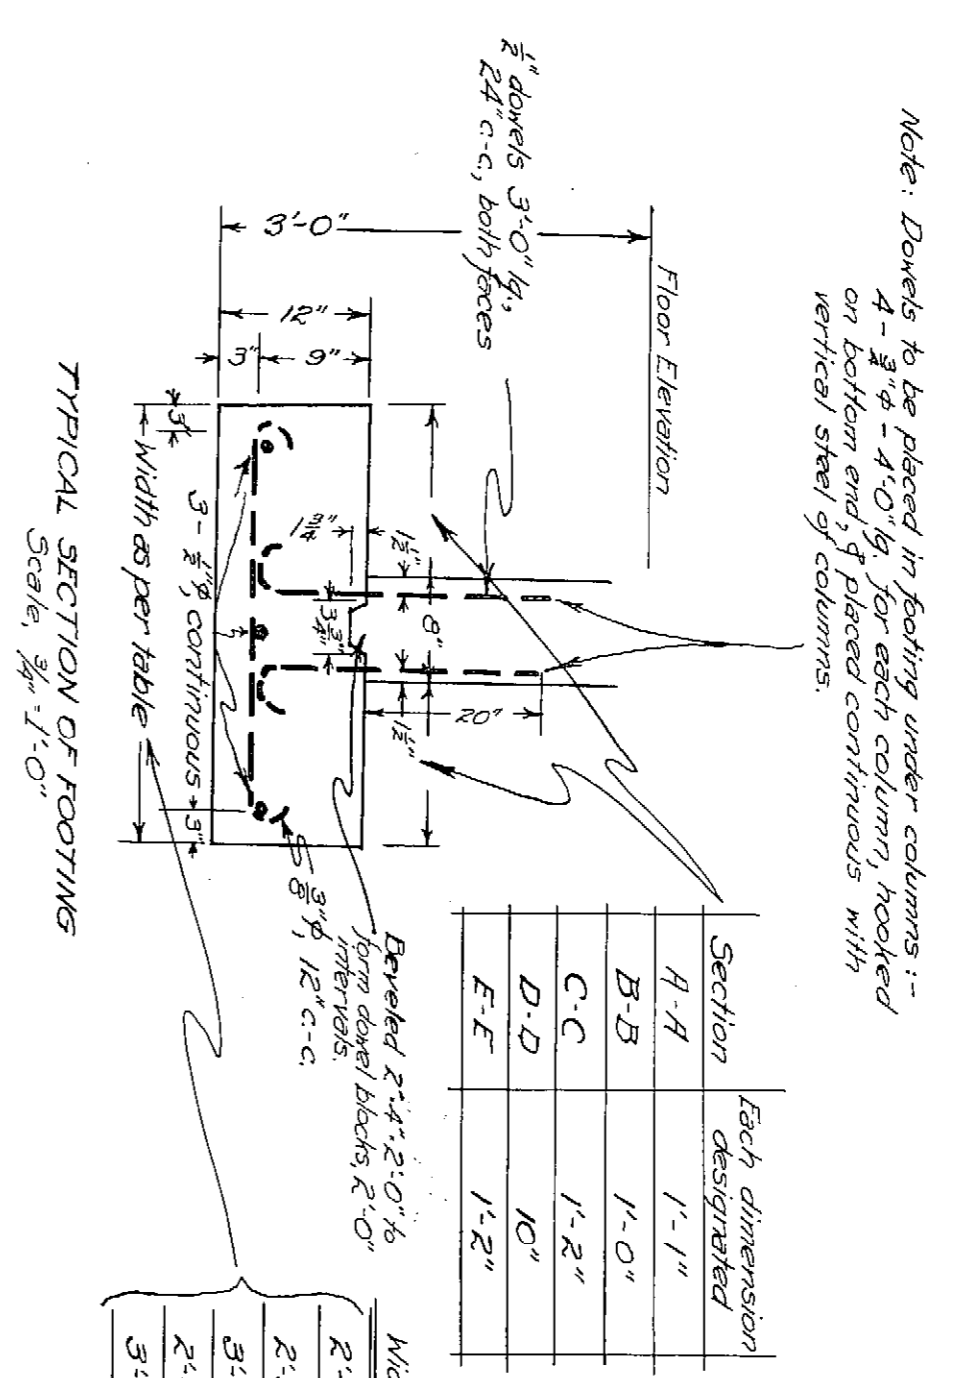
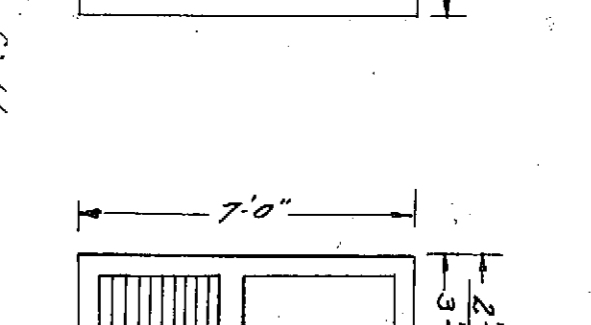
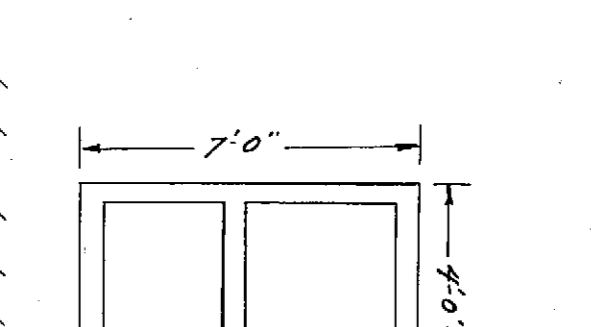
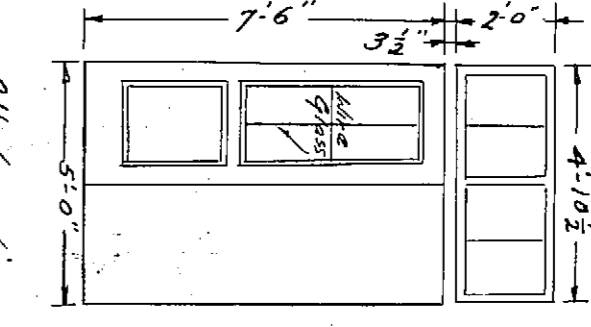
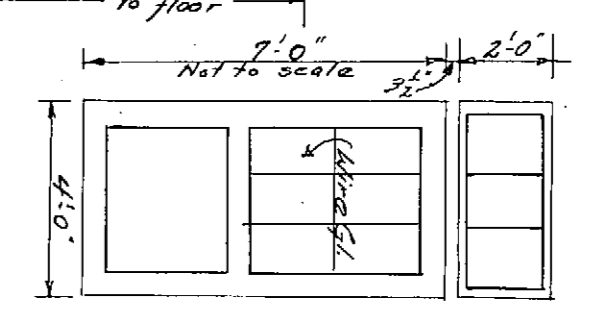
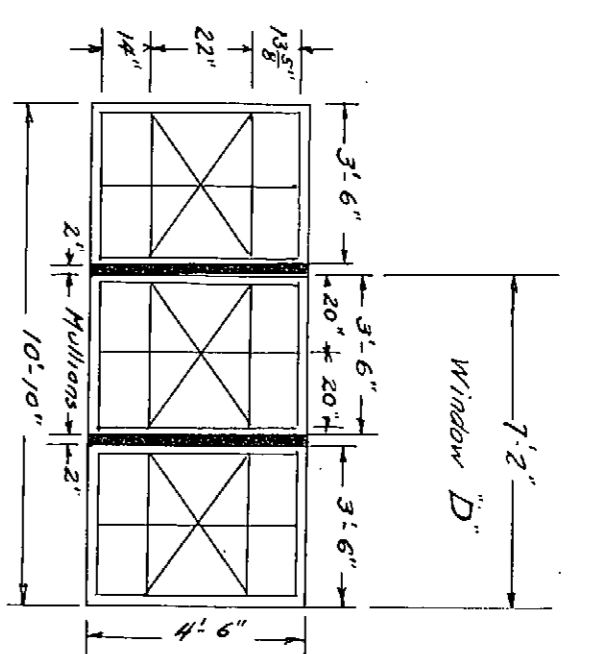
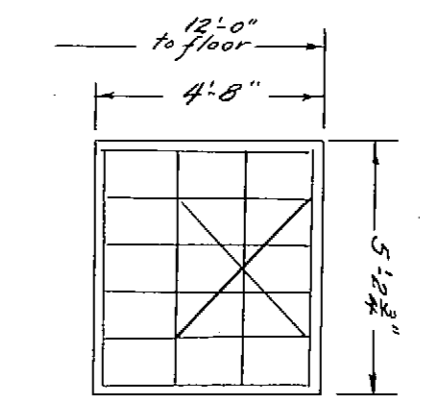


FOUNDATION PLAN
Scale 1/8" = 1'-0"

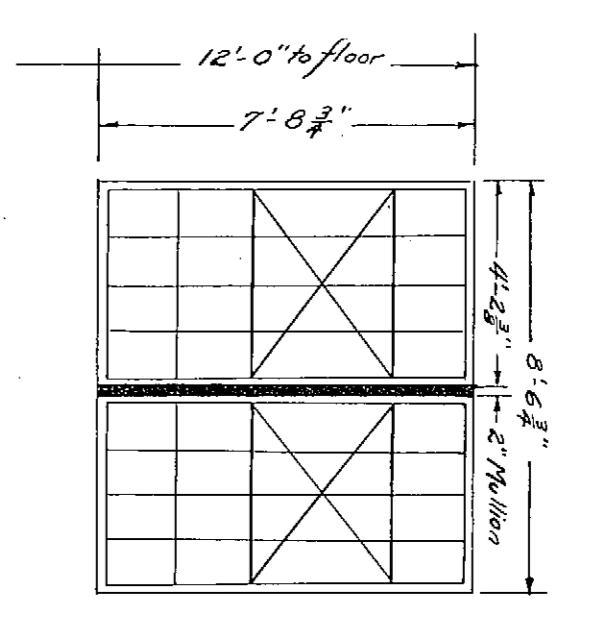

Section designated	Each dimension	Section of Footing	Unit Dead Pressure	Unit Live Pressure
A-A	1'-1"	A-A	1200 #/ft	1400 #/ft
B-B	1'-0"	B-B	1200	1230
C-C	1'-2"	C-C	1200	1330
D-D	1'-0"	D-D	1200	1200
E-E	1'-2"	E-E	1200	1330

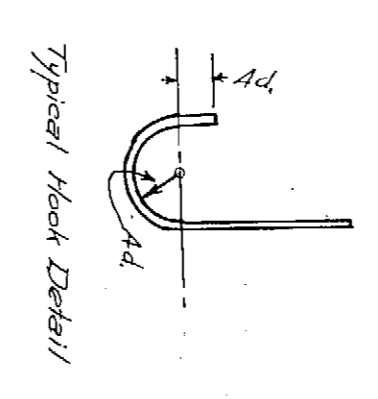

STEEL WINDOW SCHEDULE
Showing dimensions of openings.
Scale 1/4" = 1'-0"

Note: Panic Hardware to be on all doors on all overhead doors to be self-releasing from inside of building.

DOOR SCHEDULE
Scale 1/4" = 1'-0"

All door dimensions to be checked in field.

Jan 31, '34 - Revised as approved by State Architect, 1-31-34 (Original Sheet No. 1-4)

AERONAUTICS BUILDING
CHAFFEY JUNIOR COLLEGE
ONTARIO, CALIF.
JANUARY, 1934
FEB. 5, 1934
SHEET NO. 1

PD25 #196